



DEPARTMENT OF PERMITTING, ENVIRONMENT, AND REGULATORY
AFFAIRS (PERA)

BOARD AND CODE ADMINISTRATION DIVISION

NOTICE OF ACCEPTANCE (NOA)

MIAMI-DADE COUNTY, Florida
PRODUCT CONTROL SECTION

11805 SW 26 Street, Room 208

Miami, Florida 33175-2474

T (786) 315-2590 F (786) 315-2599

www.miamidade.gov/pera/

Pella Corporation

102 Main Street

Pella, IA 50219

SCOPE:

This NOA is being issued under the applicable rules and regulations governing the use of construction materials. The documentation submitted has been reviewed and accepted by Miami-Dade County PERA-Product Control Section to be used in Miami-Dade County and other areas where allowed by the Authority Having Jurisdiction (AHJ).

This NOA shall not be valid after the expiration date stated below. The Miami-Dade County Product Control Section (In Miami-Dade County) and/ or the AHJ (in areas other than Miami-Dade County) reserve the right to have this product or material tested for quality assurance purposes. If this product or material fails to perform in the accepted manner, the manufacturer will incur the expense of such testing and the AHJ may immediately revoke, modify, or suspend the use of such product or material within their jurisdiction. PERA reserves the right to revoke this acceptance, if it is determined by Miami-Dade County Product Control Section that this product or material fails to meet the requirements of the applicable building code.

This product is approved as described herein, and has been designed to comply with the Florida Building Code, including the High Velocity Hurricane Zone.

DESCRIPTION: Series "350 Premium Vinyl" White PVC Sliding Glass Door – L.M.I.

APPROVAL DOCUMENT: Drawing No. 1691, titled "350 Series Premium Vinyl impact Glass Door", sheets 01 through 07 of 07, dated 10/24/2010 with the latest revision dated 01/27/2011, prepared by W. W. Schaefer Engineering & Consulting, P. A., signed and sealed by Warren W. Schaefer, P. E., bearing the Miami-Dade County Product Control Revision stamp with the Notice of Acceptance number and Expiration date by the Miami-Dade County Product Control Section.

MISSILE IMPACT RATING: Large and Small Missile Impact Resistant.

LABELING: Each unit shall bear a permanent label with the manufacturer's name or logo, city, state, series and following statement: "Miami-Dade County Product Control Approved" unless otherwise noted herein.

RENEWAL of this NOA shall be considered after a renewal application has been filed and there has been no change in the applicable building code negatively affecting the performance of this product.

TERMINATION of this NOA will occur after the expiration date or if there has been a revision or change in the materials, use, and/ or manufacture of the product or process. Misuse of this NOA as an endorsement of any product, for sales, advertising or any other purposes shall automatically terminate this NOA. Failure to comply with any section of this NOA shall be cause for termination and removal of NOA.

ADVERTISEMENT: The NOA number preceded by the words Miami-Dade County, Florida, and followed by the expiration date may be displayed in advertising literature. If any portion of the NOA is displayed, then it shall be done in its entirety.

INSPECTION: A copy of this entire NOA shall be provided to the user by the manufacturer or its distributors and shall be available for inspection at the job site at the request of the Building Official.

This NOA revises NOA No. 11-1026.15 and consists of this page 1, evidence pages E-1, E-2 and E-3, as well as approval document mentioned above.

The submitted documentation was reviewed by Jaime D. Gascon, P. E.



J. Gascon
6/18/14

NOA No. 14-0428.05

Expiration Date: February 24, 2016

Approval Date: June 26, 2014

Page 1

NOTICE OF ACCEPTANCE: EVIDENCE SUBMITTED

A. DRAWINGS


1. Manufacturer's die drawings and sections.
(Submitted under previous NOA No. 10-1124.01)
2. Drawing No. 1691, titled "350 Series Premium Vinyl impact Glass Door", sheets 01 through 07 of 07, dated 10/24/2010 with the latest revision dated 01/27/2011, prepared by W. W. Schaefer Engineering & Consulting, P. A., signed and sealed by Warren W. Schaefer, P. E.
(Submitted under previous NOA No. 11-1026.15)

B. TESTS

1. Test reports on: 1) Air Infiltration Test, per FBC, TAS 202-94
2) Uniform Static Air Pressure Test, Loading per FBC TAS 202-94
3) Water Resistance Test, per FBC, TAS 202-94
4) Large Missile Impact Test per FBC, TAS 201-94
5) Cyclic Wind Pressure Loading per FBC, TAS 203-94
6) Forced Entry Test, 2411 3.2.1, TAS 202-94
along with marked-up drawings and installation diagram of Vinyl sliding glass door, prepared by Architectural Testing, Inc., Revised Test Report No. ATI A2676.01-201-18-R2, dated 01/25/2011, revised, signed and sealed by Joseph A. Reed, P. E.
(Submitted under previous NOA No. 10-1124.01)
2. Test reports on: 1) Air Infiltration Test, per FBC, TAS 202-94
2) Uniform Static Air Pressure Test, Loading per FBC TAS 202-94
3) Water Resistance Test, per FBC, TAS 202-94
4) Large Missile Impact Test per FBC, TAS 201-94
5) Cyclic Wind Pressure Loading per FBC, TAS 203-94
6) Forced Entry Test, 2411 3.2.1, TAS 202-94
along with marked-up drawings and installation diagram of Vinyl sliding glass door, prepared by Architectural Testing, Inc., Test Report N^o. ATI A2676.01-201-18, dated 09/28/2010, signed and sealed by Joseph A. Reed, P. E.
(Submitted under previous NOA No. 10-1124.01)

C. CALCULATIONS

1. Anchor verification calculations and structural analysis, complying with FBC, prepared by W. W. Schaefer Engineering & Consulting, P. A., dated 11/18/2010, signed and sealed by Warren W. Schaefer, P. E.
(Submitted under previous NOA No. 10-1124.01)
2. Glazing complies with ASTM E1300-04/ 09

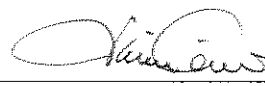

Jaime D. Gascon, P. E.
Product Control Section Supervisor
NOA No. 14-0428.05
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D. QUALITY ASSURANCE

1. Miami-Dade Department of Permitting, Environment, and Regulatory Affairs (PERA).

E. MATERIAL CERTIFICATIONS

1. Notice of Acceptance No. **11-0624.02** issued to E.I. DuPont DeNemours & Co., Inc. for their "**DuPont Sentry Glass® Interlayer**" dated 05/26/2010, expiring on 01/14/2012.
2. Notice of Acceptance No. **12-1017.02**, issued to Quanex Building Products for "**White Rigid PVC Exterior Extrusions for Windows and Doors**" dated 02/07/13, expiring on 12/26/2016.

3. Test report on:
 - 1) "Standard Test Methods for Density and Specific Gravity (Relative Density) of Plastics by Displacement" per ASTM D792-08, G=1.07;
 - 2) "Standard Test Method for Slump of Sealants" per ASTM D 2202-00, Slump < 0.1 (in);
 - 3) "Standard Test Method for Electrical Resistivity of Manufactured Carbon and Graphite Articles at Room Temperature" per ASTM C 611-98 (2010)e1, Durometer after cure shore A of 50;
 - 4) "Standard Test Method for Vulcanized Rubber and Thermoplastic Elastomers-Tension" per ASTM D412-06ae2, Tension Strength 300 psi, Modulus 400 psi and Elongation 350 %;
 - 5) "Standard Test Method for Determining Tensile Adhesion Properties of Structural Sealants" per ASTM C1135-00(2005), Stress-Strain 45 psi at 25% and 75 psi at 50%;
 - 6) "Standard Test Method for Low-Temperature Flexibility of Latex Sealants after Artificial Weathering" per ASTM C734-06, No cracking or loss of seal.


along with **PVC-AAMA 805.2-07, GROUP A**, Voluntary Specification for Bonding Back-Bedding Compound, **Purfect Glaze RT 82-238A/ H 91-351A** by National Adhesives certified profile license by AAMA Fenestration Exterior Profile Certification Program.

(Submitted under previous NOA No. 10-1124.01)

F. STATEMENTS

1. Statement letter of conformance and compliance with the **FBC 5th Edition (2014)**, dated 04/15/2014, signed and sealed by Warren W. Schaefer, P. E.
2. Statement letter of conformance and compliance with the **FBC-2010**, dated 10/20/2011, signed and sealed by Warren W. Schaefer, P. E.

(Submitted under previous NOA No. 11-1026.15)

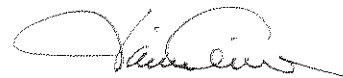

Jaime D. Gascon, P. E.
Product Control Section Supervisor
NOA No. 14-0428.05
Expiration Date: February 24, 2016
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Pella Corporation

NOTICE OF ACCEPTANCE: EVIDENCE SUBMITTED

F. STATEMENTS (CONTINUED)

3. Statement letter of no financial interest and independence, dated 10/19/2010, signed and sealed by Warren W. Schaefer, P. E.
(Submitted under previous NOA No. 11-1026.15)
4. Statement letter of no financial interest, conformance and compliance with the **FBC-2007**, dated 11/18/2010, signed and sealed by Warren W. Schaefer, P. E.
(Submitted under previous NOA No. 10-1124.01)
5. Laboratory compliance letters for Test Reports No.'s **ATI-A2676.01-201-18-R2**, and **ATI-A2676.01-201-18**, issued by Architectural Testing, Inc., dated 01/25/2011 and 09/29/2010, both signed and sealed by Joseph A. Reed, P. E.
(Submitted under previous NOA No. 10-1124.01)
6. Proposal No. **09-1503** issued by BCCO, dated November 25, 2009, signed by Ishaq Chanda, P. E.
(Submitted under previous NOA No. 10-1124.01)

G. OTHERS

1. Notice of Acceptance No. **11-1026.15**, issued to Pella Corporation for their Series "350 Premium Vinyl Sliding Glass Door - L.M.I.", approved on 12/29/2011 and expiring on 02/24/2016.



Jaime D. Gascon, P. E.
Product Control Section Supervisor
NOA No. 14-0428.05
Expiration Date: February 24, 2016
Approval Date: June 26, 2014


GENERAL NOTES:

1. THESE DOOR SYSTEMS HAVE BEEN TESTED, ANALYZED & APPROVED FOR DESIGN PRESSURES NOT TO EXCEED THOSE SHOWN IN THE "ALLOWABLE DESIGN PRESSURE TABLE(S)".
2. OPENINGS, BUCKING & BUCKING FASTENERS MUST BE PROPERLY DESIGNED & INSTALLED TO TRANSFER WIND LOADS TO THE STRUCTURE.
3. ALL HARDWARE & FASTENERS SHALL BE IN ACCORDANCE WITH THESE DRAWINGS & SHALL NOT VARY UNLESS SPECIFICALLY MENTIONED ON THE DRAWINGS. SPECIFIED ANCHOR EMBED TO BASE MATERIAL SHALL BE BEYOND WALL FINISH OR STUCCO.
4. THE DETAILS & SPECIFICATIONS SHOWN HEREIN REPRESENT THE PRODUCTS TESTED & PROPOSED FOR WATER, AIR, IMPACT, CYCLIC & UNIFORM STATIC AIR PRESSURE TESTING IN CONFORMANCE WITH THE FLORIDA BUILDING CODE PROTOCOLS TAS-201, 202 & 203 FOR LARGE MISSILE IMPACT DOORS.
5. THESE DOOR SYSTEMS HAVE BEEN DESIGNED IN ACCORDANCE WITH AND MEET THE REQUIREMENTS OF THE FLORIDA BUILDING CODE (FBC) INCLUDING HIGH VELOCITY HURRICANE ZONES (HVHZ).
6. IMPACT SHUTTERS ARE NOT REQUIRED WITH THESE DOORS.
7. ALL ANCHORS SECURING DOOR FRAME TO PRESSURE TREATED BUCKS OR WOOD FRAMING SHALL BE CAPABLE OF RESISTING CORROSION CAUSED BY THE PRESSURE TREATING CHEMICALS IN THE WOOD.
8. DETERMINE THE POSITIVE & NEGATIVE DESIGN LOADS TO USE WHEN REFERENCING THESE DOCUMENTS IN ACCORDANCE WITH THE GOVERNING CODE AND GOVERNING WIND VELOCITY. FOR WIND LOAD CALCULATIONS IN ACCORDANCE WITH THE FLORIDA BUILDING CODE, A DIRECTIONALITY FACTOR OF $K_d = 0.85$ MAY BE APPLIED PER THE ASCE-7 STANDARD.
9. NO INCREASE IN ALLOWABLE STRESS HAS BEEN USED IN THE CERTIFICATION OF THIS PRODUCT. WIND LOAD DURATION FACTOR $C_d = 1.6$ WAS USED FOR WOOD SCREW ANALYSIS ONLY.
10. MATERIALS, INCLUDING BUT NOT LIMITED TO STEEL SCREWS, THAT COME INTO CONTACT WITH OTHER DISSIMILAR MATERIALS SHALL MEET THE REQUIREMENTS OF FLORIDA BUILDING CODE CHAPTER 20.


CORNER CONSTRUCTION:

FRAME: MEMBERS ARE MITERED, BUTTED AND FULLY WELDED
 PANEL: MEMBERS ARE MITERED, BUTTED AND FULLY WELDED

PRODUCT REVISED
 s complying with the Florida
 Building Code
 Acceptance No. 14-0428.05
 Expiration Date 02/26/2016

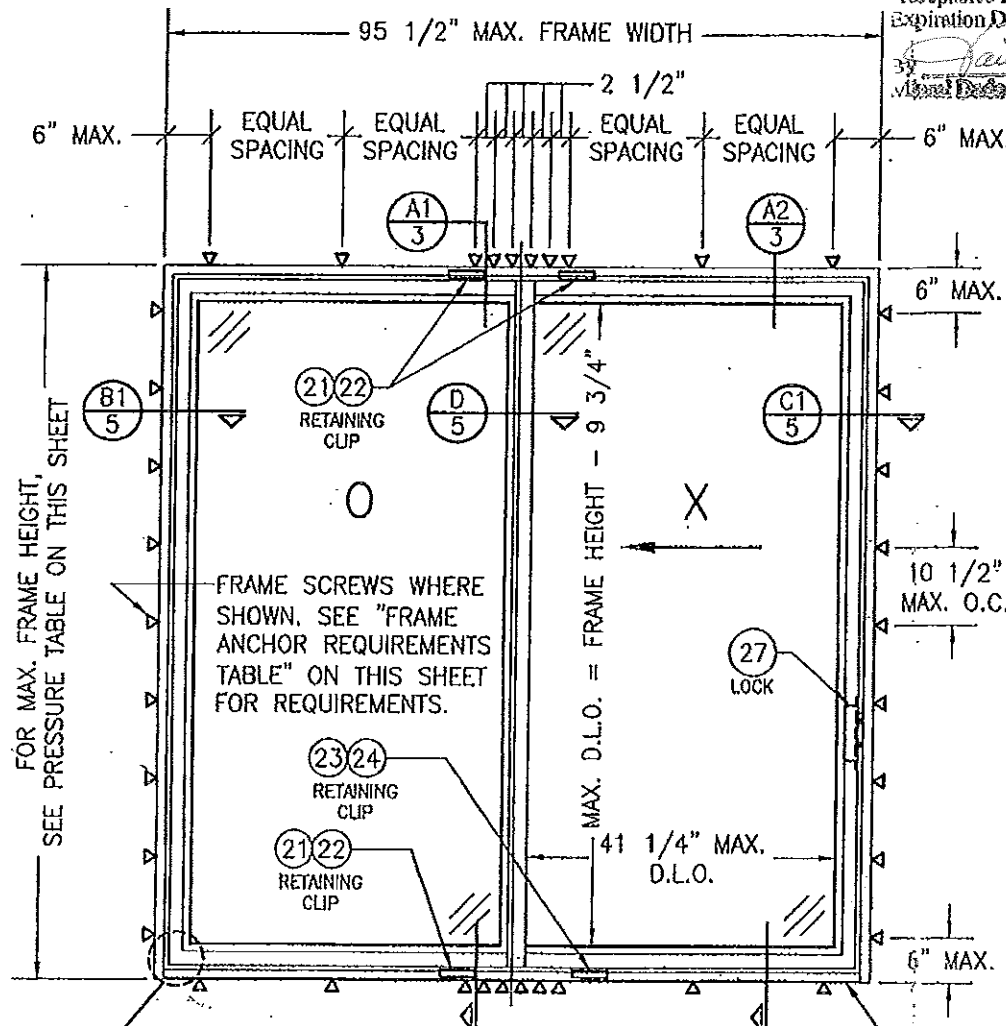

EXTERIOR ELEVATION:
2 PANEL DOOR
(SINGLE ANCHOR ROW CONDITION)
 ("OX" CONDITION SHOWN, "XO" CONDITION ALSO APPLIES)
 SCALE: 1/2" = 1'-0"

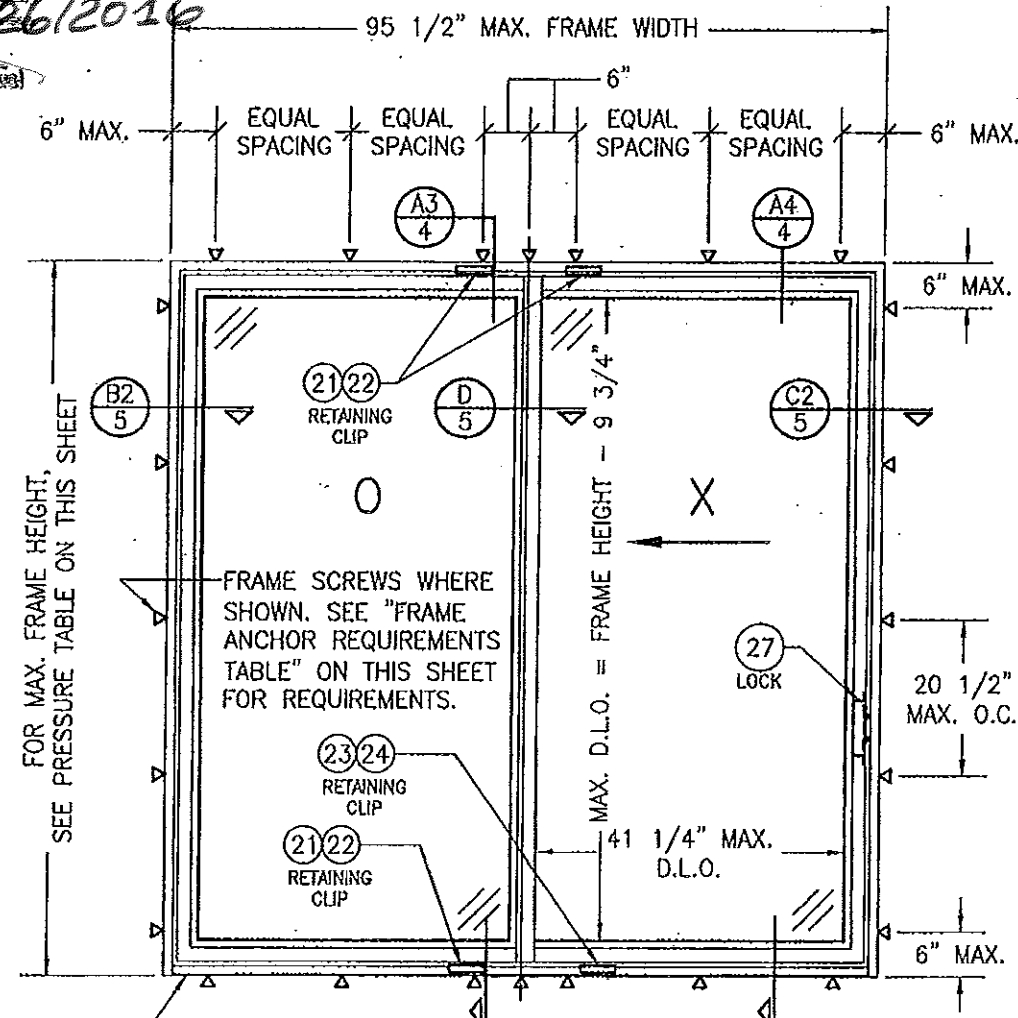

EXTERIOR ELEVATION:
2 PANEL DOOR
(DOUBLE ANCHOR ROW CONDITION)
 ("OX" CONDITION SHOWN, "XO" CONDITION ALSO APPLIES)
 SCALE: 1/2" = 1'-0"

FRAME ANCHOR REQUIREMENTS TABLE

FRAME & RETAINING CLIP SCREWS

OPENING TYPE (SUBSTRATE)	(2) FRAME TO OPENING FASTENER TYPE	MINIMUM EMBED	MINIMUM EDGE DIST.
MIN. 2X6 WOOD FRAME OR BUCK (MIN. GR. 3 & G=0.55)	NO. 10 SMS OR WOOD SCREW	()	3/4"
MIN. 18 GA. 33 KSI METAL STUD	NO. 10 GR. 5 SELF TAP/DRILL SCREW	FULL	1/2"
MIN. 1/8" THK A36 STEEL	NO. 10 GR. 5 SELF TAP/DRILL SCREW	FULL	1/2"
MIN. 1/8" THK 6063-T5 ALUM.	NO. 10 GR. 5 SELF TAP/DRILL SCREW	FULL	1/2"
MIN. C-90 CMU OR 2500 PSI CONCRETE	(1) 1/4" CONCRETE SCREW (FRAME SCREWS)	1 1/4"	2"
MIN. 2500 PSI CONCRETE	(1) 3/16" CONCRETE SCREW (RETAINING CLIP SCREWS)	1 1/4"	2"

- (1) CONCRETE SCREWS SHALL BE ELCO ULTRACONS, ELCO CRETE-FLEX, ITW RAMSET/RED HEAD TAPCONS OR HILTI KWIK-CON II (HARDENED STEEL OR S.S.).
 (2) ALL FRAME SCREWS SHALL BE EITHER PAN HEAD OR HEX HEAD SCREWS.

1 1/4" WITH
 FRAME SCREWS;
 1" WITH RETAINING
 CLIP SCREWS.

ALLOWABLE DESIGN PRESSURE

(ALL CONDITIONS)

MAX. FRAME HEIGHT (IN.)	ALLOWABLE PRESSURE	
	POSITIVE (PSF)	NEGATIVE (PSF)
95 1/2"	50	50
83 1/2"	65	75





SEE SECTIONS A1 & A2 FOR
 INSTALLATION OF REINFORCEMENT
 CLIPS. CLIPS ARE TO BE
 POSITIONED 5" TO 8" OFF
 CENTERLINE OF MEETING AND
 INTERLOCK STILES.

Approved as complying with the
 Florida Building Code
 Date 02/24/2011
 NOA# 10-1124.01
 Miami-Dade Product Control
 By [Signature]



PRODUCT REVISED
 as complying with the Florida
 Building Code
 Acceptance No. 11-1026.15
 Expiration Date 02/24/2016
 By [Signature]
 Miami-Dade Product Control

DRAWN BY: W.W.S.		CHECKED BY: W.W.S.	
PLOT: 1-24		DATE: 10/24/10	
NO.	REVISION DESCRIPTION	DATE	BY
350 SERIES PREMIUM VINYL IMPACT SLIDING GLASS DOOR MANUFACTURER: PELLA CORPORATION 102 MAIN STREET PELLA, IA 50219 641-621-1000 CONSULTANTS: W. W. SCHAEFER ENGINEERING & CONSULTING, P.A. (CA 6809) 7480 150TH COURT NORTH PALM BEACH GARDENS, FL 33418 PHONE 561-744-3424 CERTIFICATION: JAN 27 2011 DRAWING NO. 1691 SHEET NO. 1 OF 7			

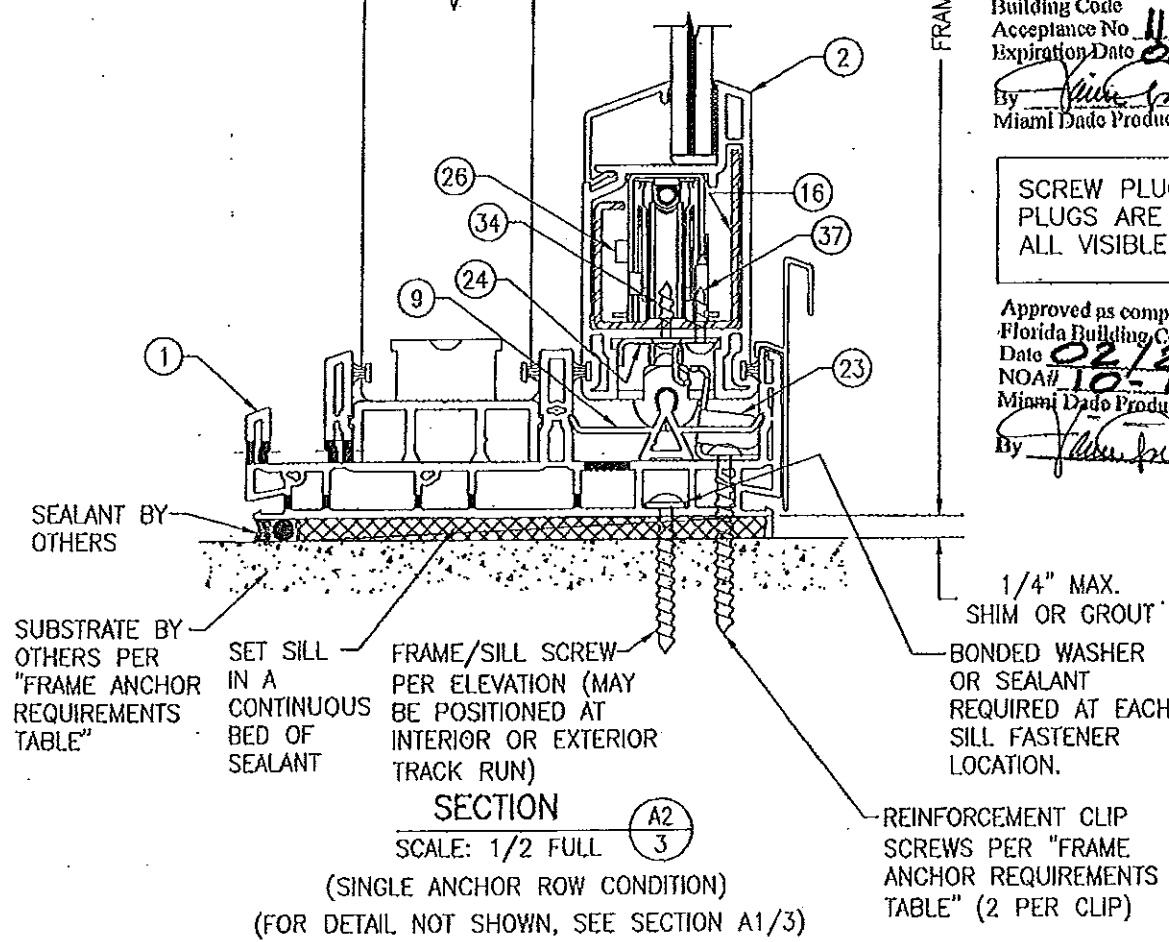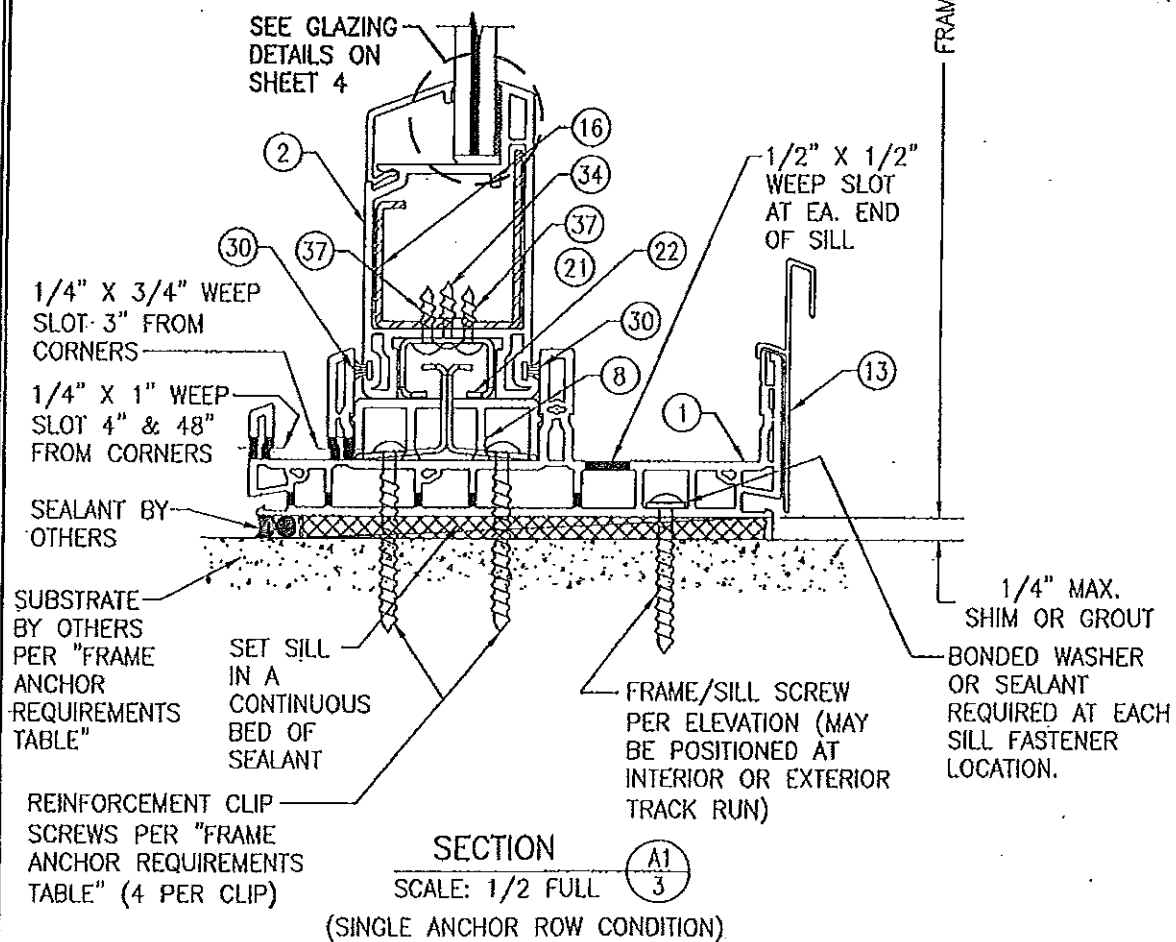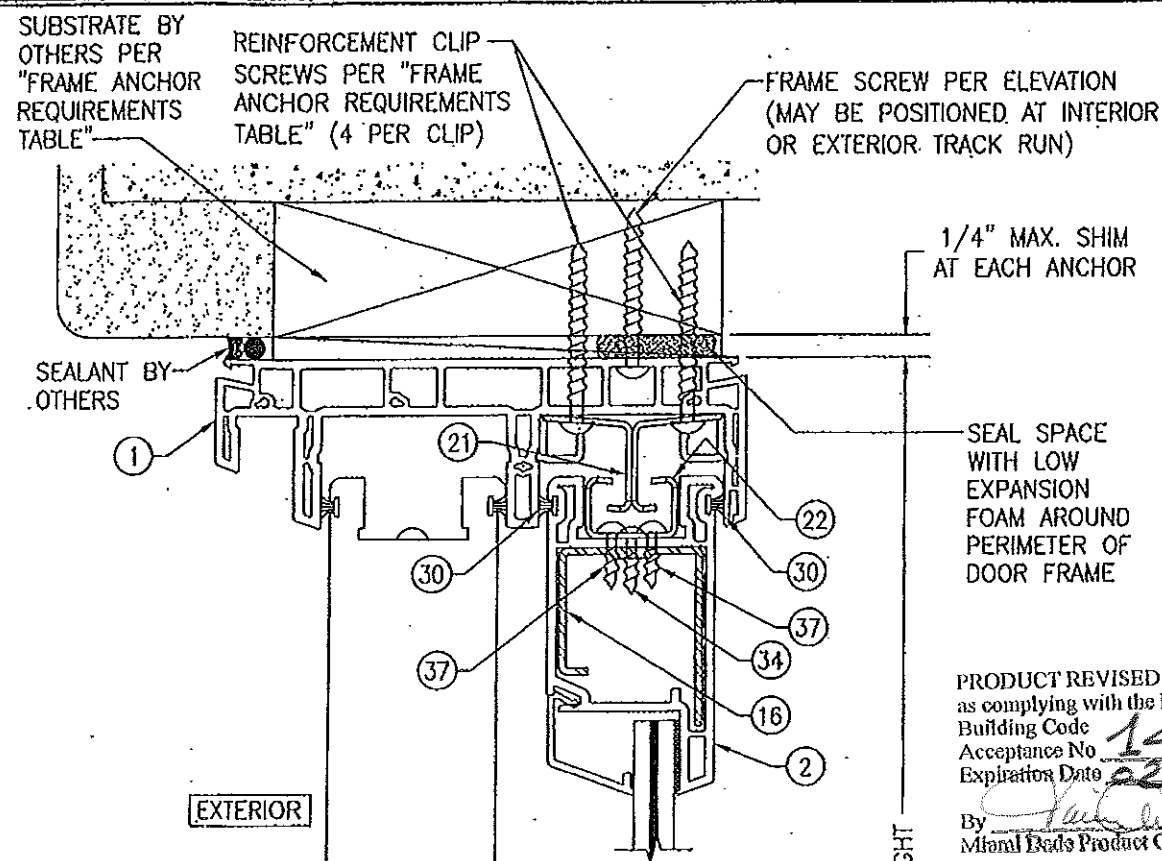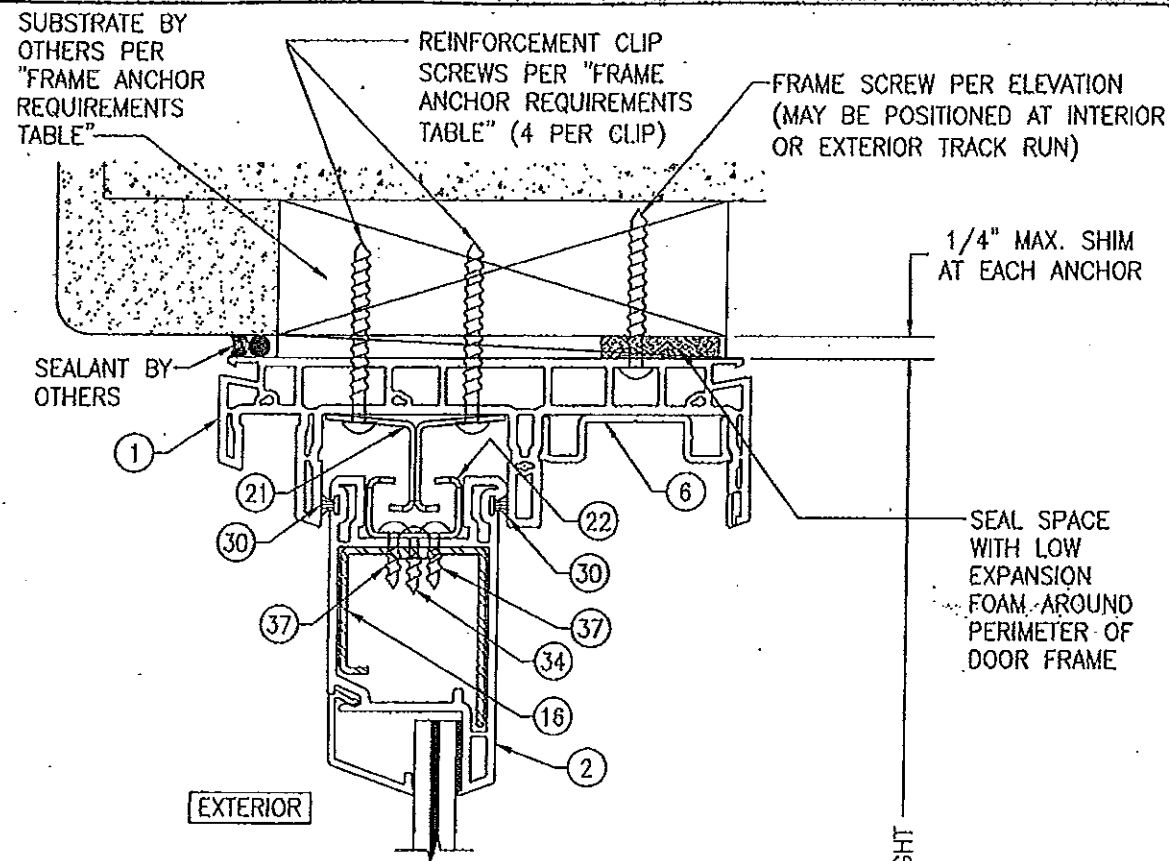


PRODUCT REVISED
as complying with the Florida
Building Code
Acceptance No. **14-0428.05**
Expiration Date **02/26/2016**
By *[Signature]*
Miami Dade Product Control



PRODUCT REVISED
as complying with the Florida
Building Code
Acceptance No. **11-1026.15**
Expiration Date **02/24/2016**
By *[Signature]*
Miami Dade Product Control

SCREW PLUG NOTE: SCREW
PLUGS ARE TO BE PLACED IN
ALL VISIBLE HOLES.

Approved as complying with the
Florida Building Code
Date **02/24/2011**
NOA# **10-1124.81**
Miami Dade Product Control
By *[Signature]*

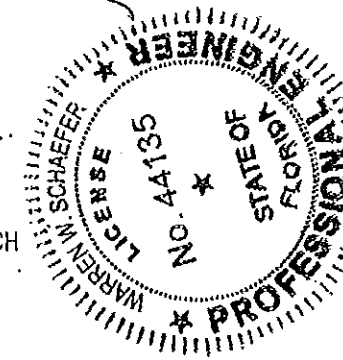

DRAWN BY: W.R.M.	CHECKED BY: W.W.S.
PLOT: 1-2	DATE: 10/15/10
DATE	BY
REVISION	DESCRIPTION
NO.	
DRAWING TITLE 350 SERIES PREMIUM VINYL IMPACT SLIDING GLASS DOOR	
CONSULTANTS W. W. SCHAEFER ENGINEERING & CONSULTING, P.A. (CA 6809)	MANUFACTURER PELLA CORPORATION 102 MAIN STREET PELLA, IA 50219 641-621-1000
7480 150TH COURT NORTH PALM BEACH GARDENS, FL 33418 PHONE: 561-744-3424	
CERTIFICATION WARREN W. SCHAEFER, P.E. P.E. NO. 44135	DRAWING NO. 1691 SHEET NO. 3 OF 7

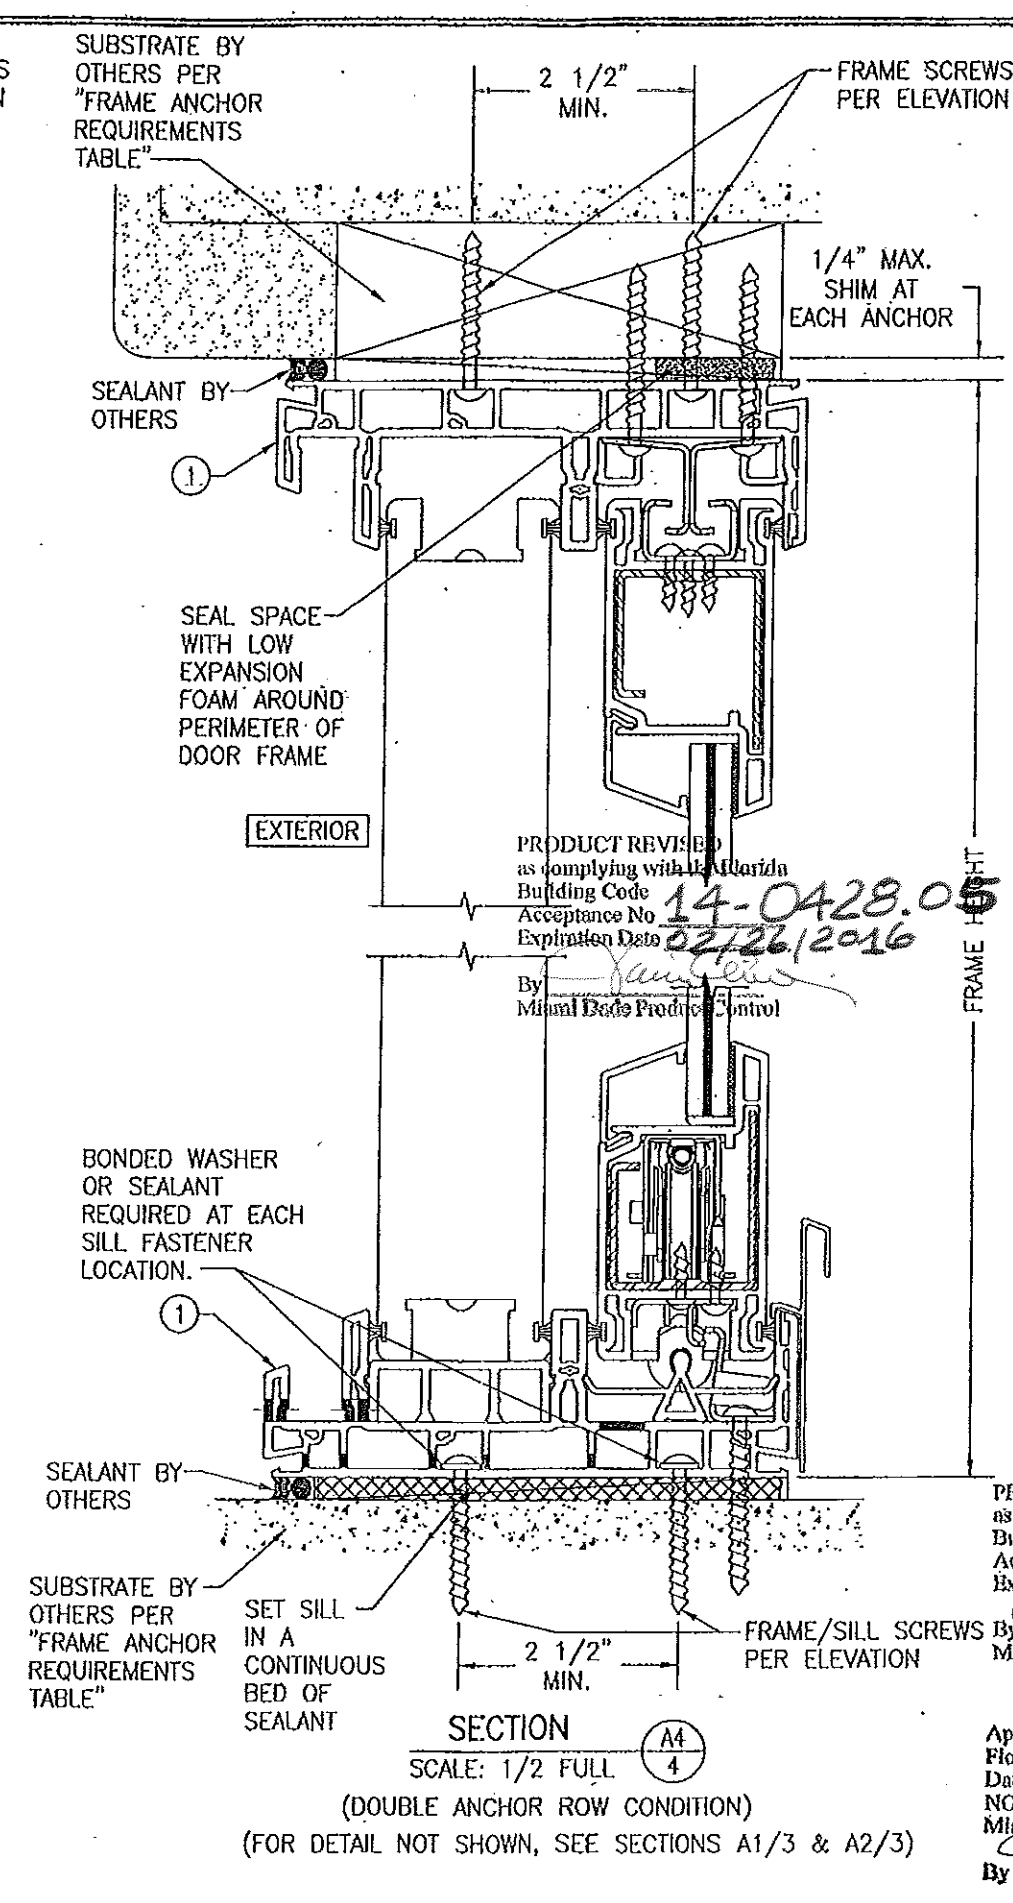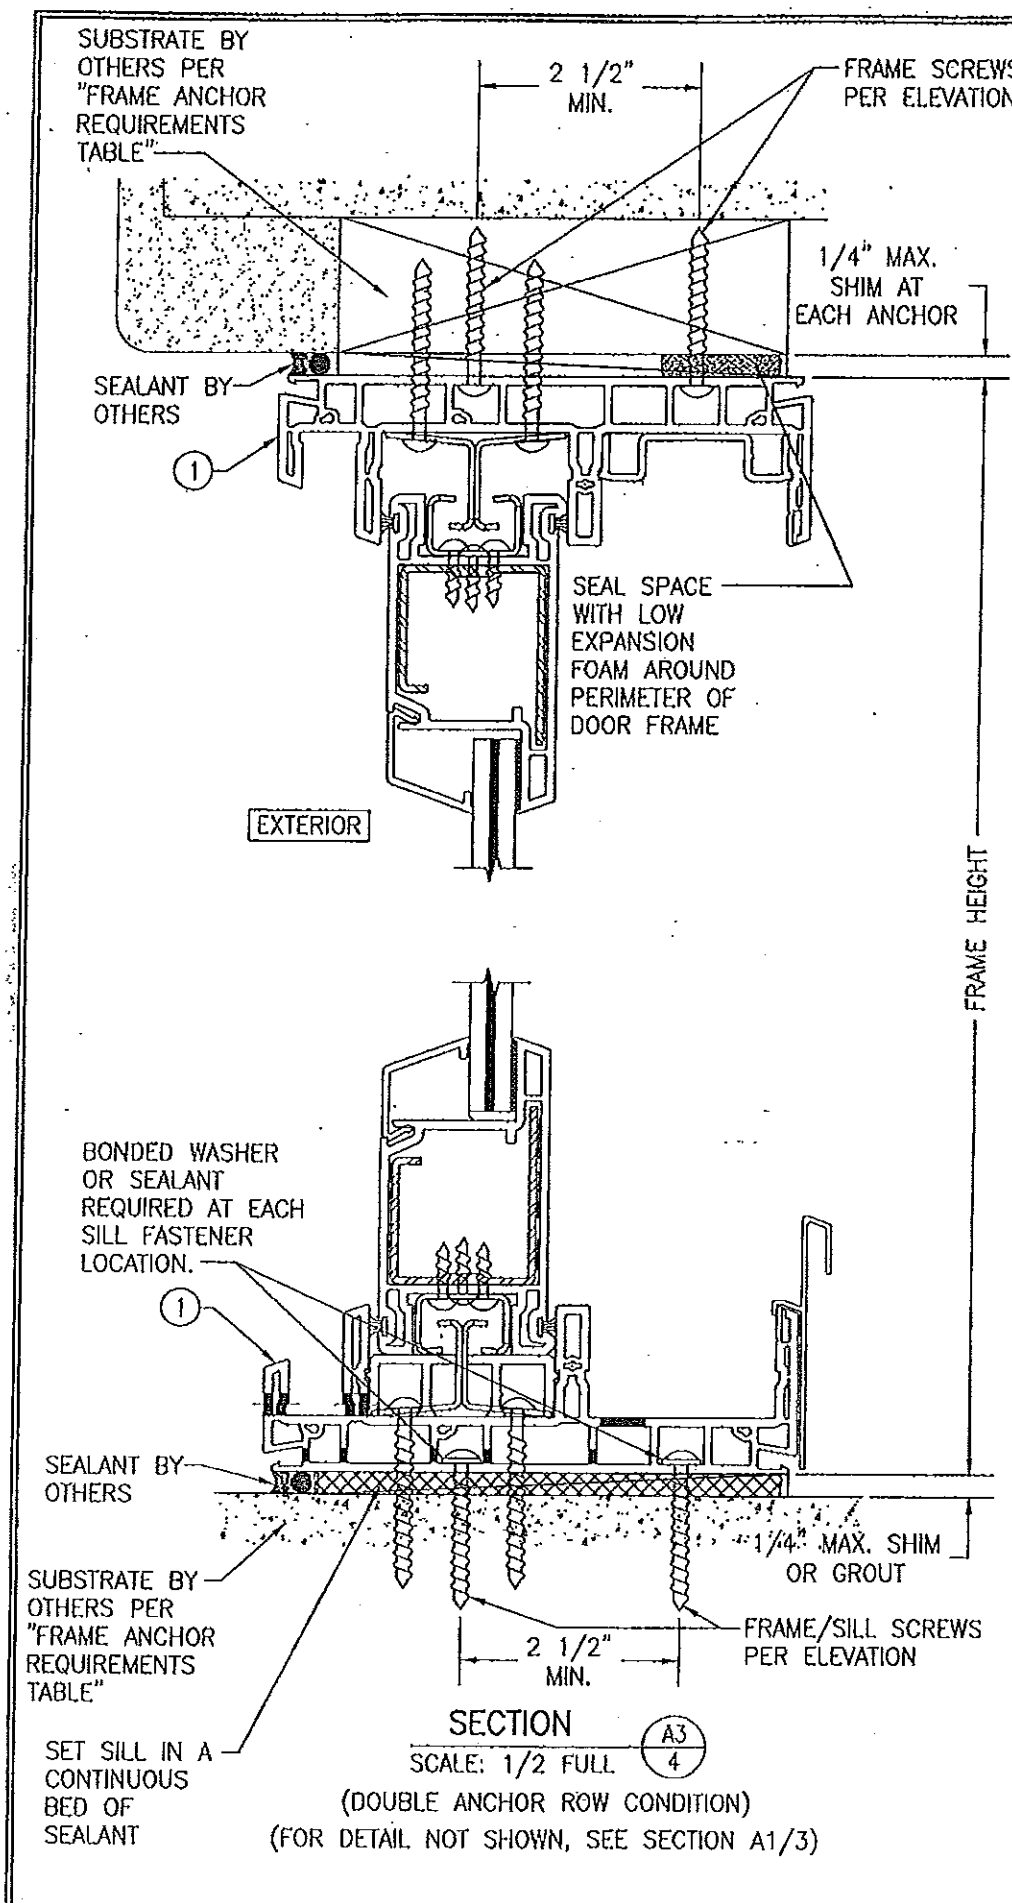

SEE GLASS OPTIONS BELOW

13/16" MIN. BITE

EXTERIOR

SETTING BLOCK AS REQ'D

HENKEL PERFECT GLAZE "H" HOT MELT POLYURETHANE BACKBEDDING (1/2" MIN. GLASS SURFACE BOND)

(2) (3) (4)

TYPICAL GLAZING DETAIL (NON-I.G. CONDITION)

GLASS OPTION 1: 15/32" LAMINATED GLASS (3/16" AN./0.09 DUPONT SGI/3/16" AN.)

SEE GLASS OPTIONS BELOW

13/16" MIN. BITE

EXTERIOR

SETTING BLOCK AS REQ'D

HENKEL PERFECT GLAZE "H" HOT MELT POLYURETHANE BACKBEDDING (1/2" MIN. GLASS SURFACE BOND)

(2) (3) (4)

TYPICAL GLAZING DETAIL (I.G. CONDITION)

GLASS OPTION 2: 1" THICK I.G. LAMINATED GLASS (3/16" TEMP. EXTERIOR; 3/8" SPACER; 3/16" AN./0.09 DUPONT SGI/3/16 AN. INTERIOR)

PRODUCT REVISED as complying with the Florida Building Code

Acceptance No. 11-1026.15

Expiration Date 02/24/2016

By *[Signature]*

Miami Dade Product Control

Approved as complying with the Florida Building Code

Date 02/24/2011

NOA# 10-1124.01

Miami Dade Product Control

By *[Signature]*

WARREN W. SCHAEFER


NO. 44135

FLORIDA

PROFESSIONAL ENGINEER

JAN 27 2011

DRAWING TITLE		350 SERIES PREMIUM VINYL IMPACT SLIDING GLASS DOOR	
CONSULTANTS		W. W. SCHAEFER ENGINEERING & CONSULTING, P.A. (CA 6809)	
MANUFACTURER		PELLA CORPORATION	
DRAWING NO.		1691	
SHEET NO.		4 OF 7	

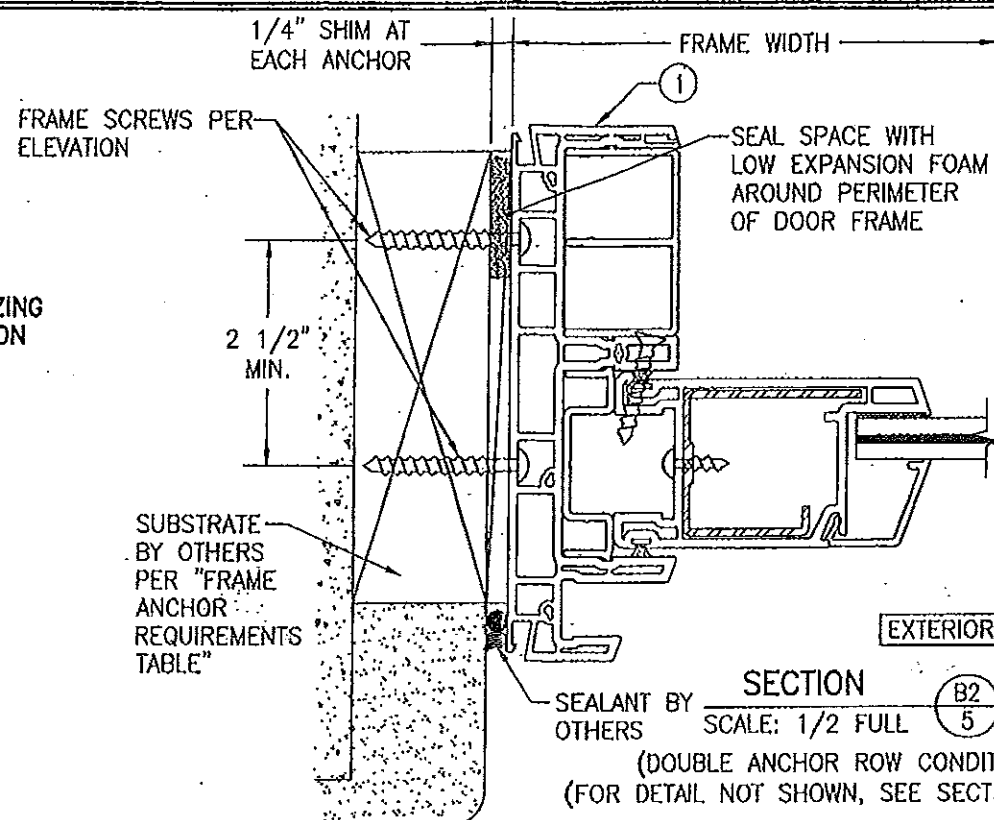

1/4" SHIM AT EACH ANCHOR

SEAL SPACE WITH LOW EXPANSION FOAM AROUND PERIMETER OF DOOR FRAME

2 1/2" MIN.

FRAME SCREWS PER ELEVATION

SUBSTRATE BY OTHERS PER "FRAME ANCHOR REQUIREMENTS TABLE"

SEALANT BY OTHERS

EXTERIOR


SECTION


SCALE: 1/2 FULL

C2
5

PROD as com Building Accept Expira By Miami

Approved as complying with the
Florida Building Code
Date 02/24/201
NOA# 10-1124.01
Miami Dade Product Control
By [Signature]

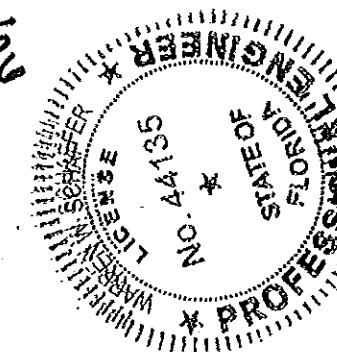
[illegible]

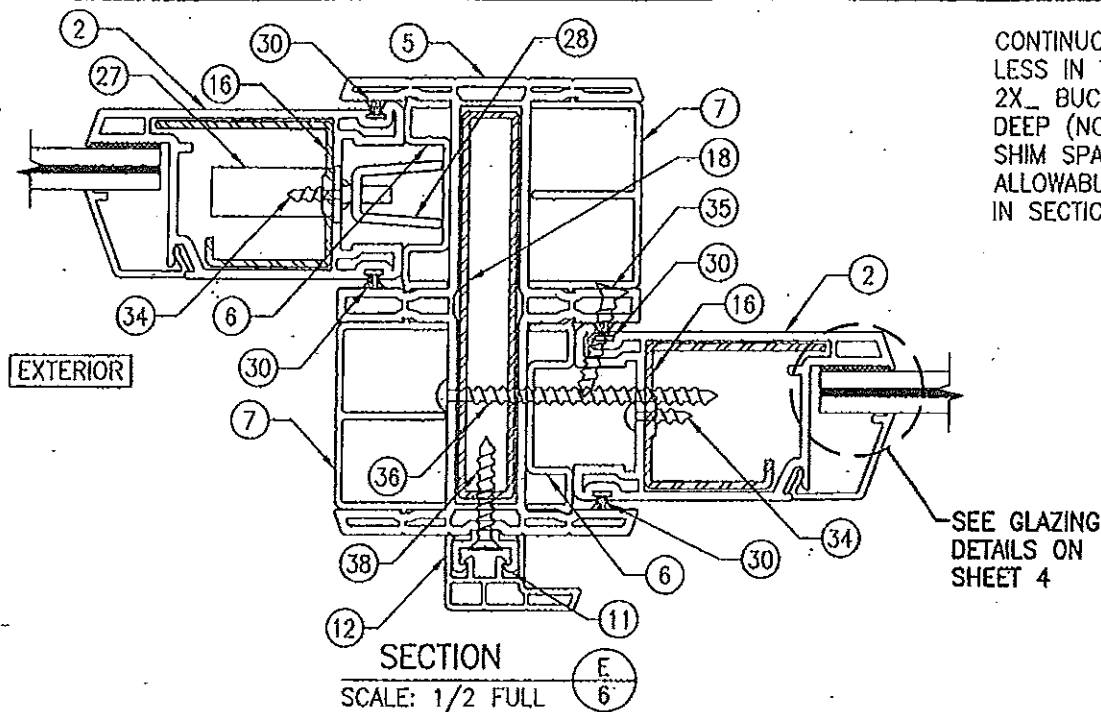

CONTINUOUS WOOD MEMBER
LESS IN THICKNESS THAN A
2X. BUCK TO BE MIN. 5 1/2"
DEEP (NOT REQUIRED WHEN
SHIM SPACE IS WITHIN
ALLOWABLE DIMENSIONS SHOWN
IN SECTIONS).

SEALANT BY
OTHERS

SEE GLAZING
DETAILS ON
SHEET 4

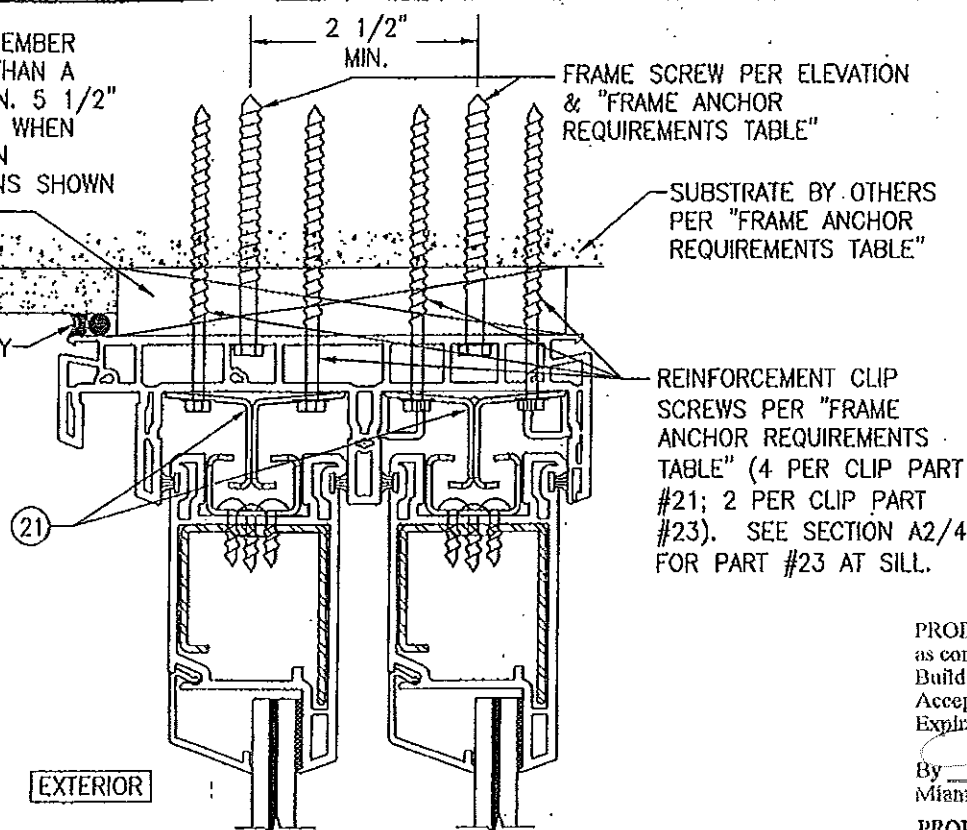


OPTIONAL DIRECT MOUNT DETAIL TO SUBSTRATE WITH SPACER


(HEAD SECTION SHOWN; SILL & SIDES ARE INSTALLED THE SAME
EXCEPT THERE ARE NO REINFORCEMENT CLIPS AT THE SIDES)
(FOR DETAIL NOT SHOWN, SEE OTHER SECTIONS)
(DOUBLE ROW OF FRAME ANCHORS SHOWN. SINGLE
ROW, CONDITION ALSO APPLIES)

PRODUCT REVISED
as complying with the Florida
Building Code
Acceptance No. **14-0428.05**
Expiration Date **02/26/2016**
By *[Signature]*
Miami Dade Product Control


PRODUCT REVISED
as complying with the Florida
Building Code
Acceptance No. **11-1026.15**
Expiration Date **02/29/2016**
By *[Signature]*
Miami Dade Product Control

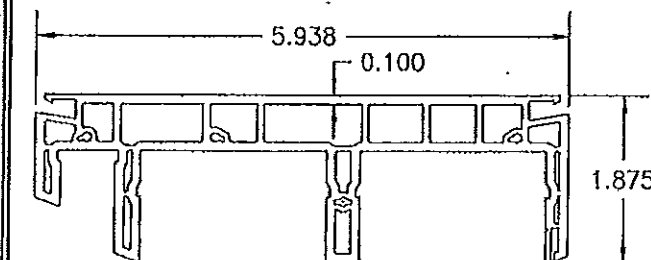


1 FRAME

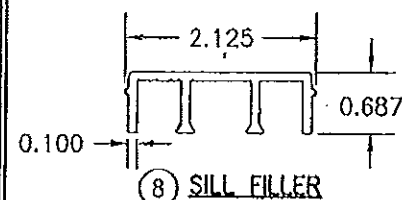


8 SILL FILLER

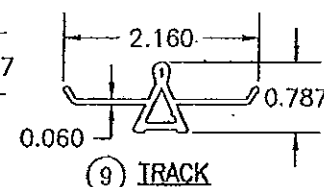


9 TRACK

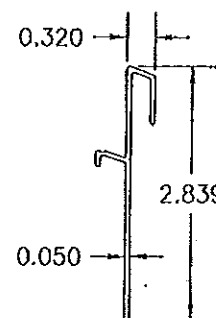


13 +65 SILL RISER

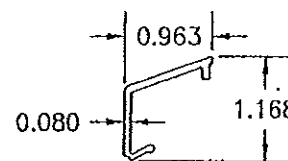


14 NON-I.G.
GLAZING BEAD

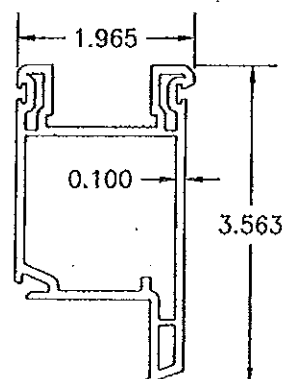


2 STILE & RAIL

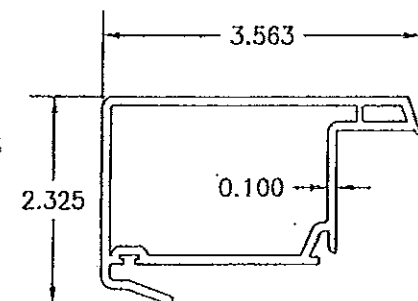


3 INTERLOCK STILE (ACTIVE PANEL)

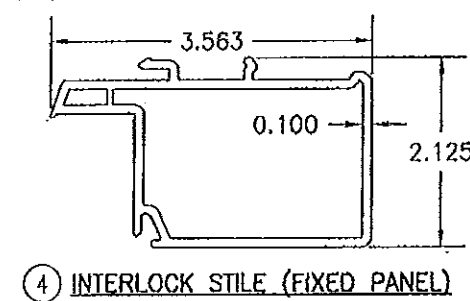


4 INTERLOCK STILE (FIXED PANEL)

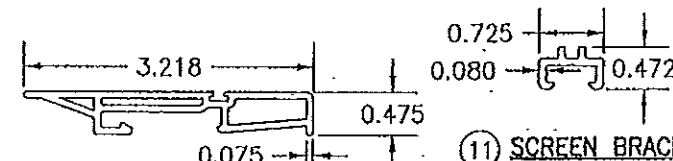


11 SCREEN BRACKET

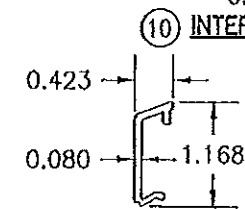


10 INTERLOCK

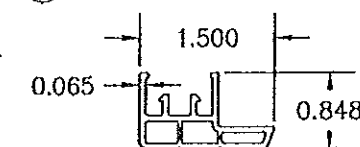


12 SCREEN RECEIVER

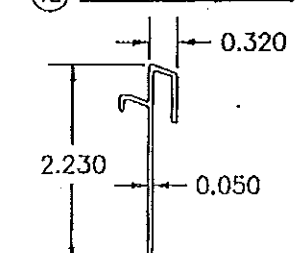


32 +50 SILL RISER

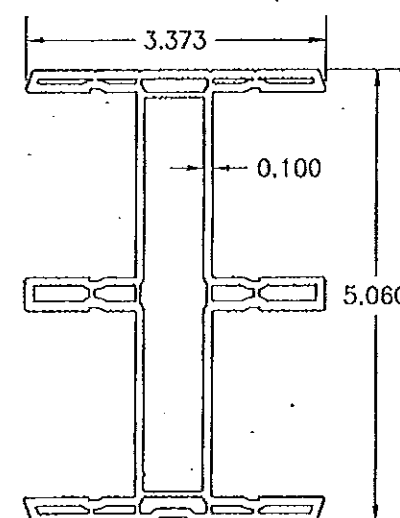

5 ASTRAGAL

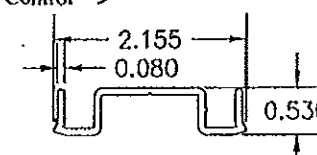


6 TRACK FILLER

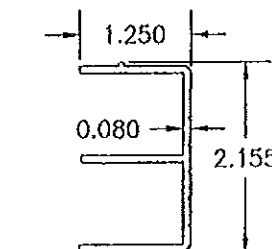


7 TRACK FILLER

Approved as complying with the
Florida Building Code
Date **02/24/2011**
NOA **10-1124.01**
Miami Dade Product Control
By *[Signature]*

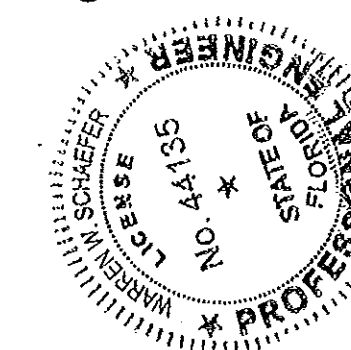

DRAWN BY: W.R.M.	CHECKED BY: W.W.S.
PLOT: 1-2	DATE: 10/15/10
DATE	BY
REVISION DESCRIPTION	NO.
350 SERIES PREMIUM VINYL IMPACT SLIDING GLASS DOOR	
CONSULTANTS W. W. SCHAEFER ENGINEERING & CONSULTING, P.A. (CA 6809) 7480 150TH COURT NORTH PALM BEACH GARDENS, FL 33418 PHONE: 561-744-3424	
MANUFACTURER PELLA CORPORATION 102 MAIN STREET PELLA, IA 50219 641-621-1000	
CERTIFICATION	JAN 27 2011
DRAWING NO.	REV.
1691	
SHEET NO.	6 OF 7


ITEM #	ITEM DESCRIPTION	MANUFACTURER/NOTES
PARTS		
1	FRAME	WHITE RIGID PVC BY SPECTUS SYSTEMS
2	STILE & RAIL	WHITE RIGID PVC BY SPECTUS SYSTEMS
3	INTERLOCK STILE (ACTIVE PANEL)	WHITE RIGID PVC BY SPECTUS SYSTEMS
4	INTERLOCK STILE (FIXED PANEL)	WHITE RIGID PVC BY SPECTUS SYSTEMS
5	ASTRAGAL	WHITE RIGID PVC BY SPECTUS SYSTEMS
6	TRACK FILLER	WHITE RIGID PVC BY SPECTUS SYSTEMS
7	TRACK FILLER	WHITE RIGID PVC BY SPECTUS SYSTEMS
8	SILL FILLER	WHITE RIGID PVC BY SPECTUS SYSTEMS
9	TRACK	WHITE RIGID PVC BY SPECTUS SYSTEMS
10	INTERLOCK	WHITE RIGID PVC BY SPECTUS SYSTEMS
11	SCREEN BRACKET	WHITE RIGID PVC BY SPECTUS SYSTEMS
12	SCREEN RECEIVER	WHITE RIGID PVC BY SPECTUS SYSTEMS
13	+65 SILL RISER (REQUIRED WHEN JOB REQUIRED POSITIVE DESIGN PRESSURE IS GREATER THAN +50 PSF)	6061-T6 ALUMINUM
14	NON-I.G. GLAZING BEAD	WHITE RIGID PVC BY SPECTUS SYSTEMS
15	I.G. GLAZING BEAD	WHITE RIGID PVC BY SPECTUS SYSTEMS
16	STILE & RAIL REINFORCEMENT	6063-T6 ALUMINUM
17	INTERLOCK STILE REINFORCEMENT	6063-T6 ALUMINUM
18	ASTRAGAL REINFORCEMENT	6063-T6 ALUMINUM
19	3/8" SPACER	CARDINAL XL EDGE (BOX SHAPED)
20	INTERLOCK TUBE REINFORCEMENT	1020 GALVANIZED STEEL
21	FRAME RETAINING CLIP	301 STAINLESS STEEL
22	PANEL RETAINING CLIP	301 STAINLESS STEEL
23	SILL RETAINING CLIP	301 STAINLESS STEEL
24	VENT SILL RETAINING CLIP	301 STAINLESS STEEL
25	+50 SILL RISER (N/A WHEN JOB REQUIRED POSITIVE DESIGN PRESSURE IS GREATER THAN +50 PSF)	6061-T6 ALUMINUM
HARDWARE		
26	ROLLER ASSEMBLY	TRUTH 38.13.00.053
27	2-POINT LOCK	TRUTH 13323
28	LOCK KEEPER	TRUTH 33184
SEALS & SEALANTS		
30	PILE WEATHERSTRIP	ULTRAFAB W23271UW
FASTENERS		
34	NO. 6 X 5/8" PH SELF DRILLING SCREW	1 AT MID-SPAN OF EACH REINFORCED STILE & RAIL
35	NO. 10 X 1 1/2" FH SCREW	1 AT MID-HEIGHT OF PANEL & 16" FROM HEAD & SILL
36	NO. 10 X 3 5/16" SS HH SCREW	1 AT MID-HEIGHT OF PANEL & 16" FROM HEAD & SILL
37	NO. 6 X 5/8" PH SELF DRILLING SCREW	2 PER CLIP
38	NO. 6 X 1" FH SELF DRILLING SCREW	5 TOTAL 3" OF ENDS & EQUALLY SPACED

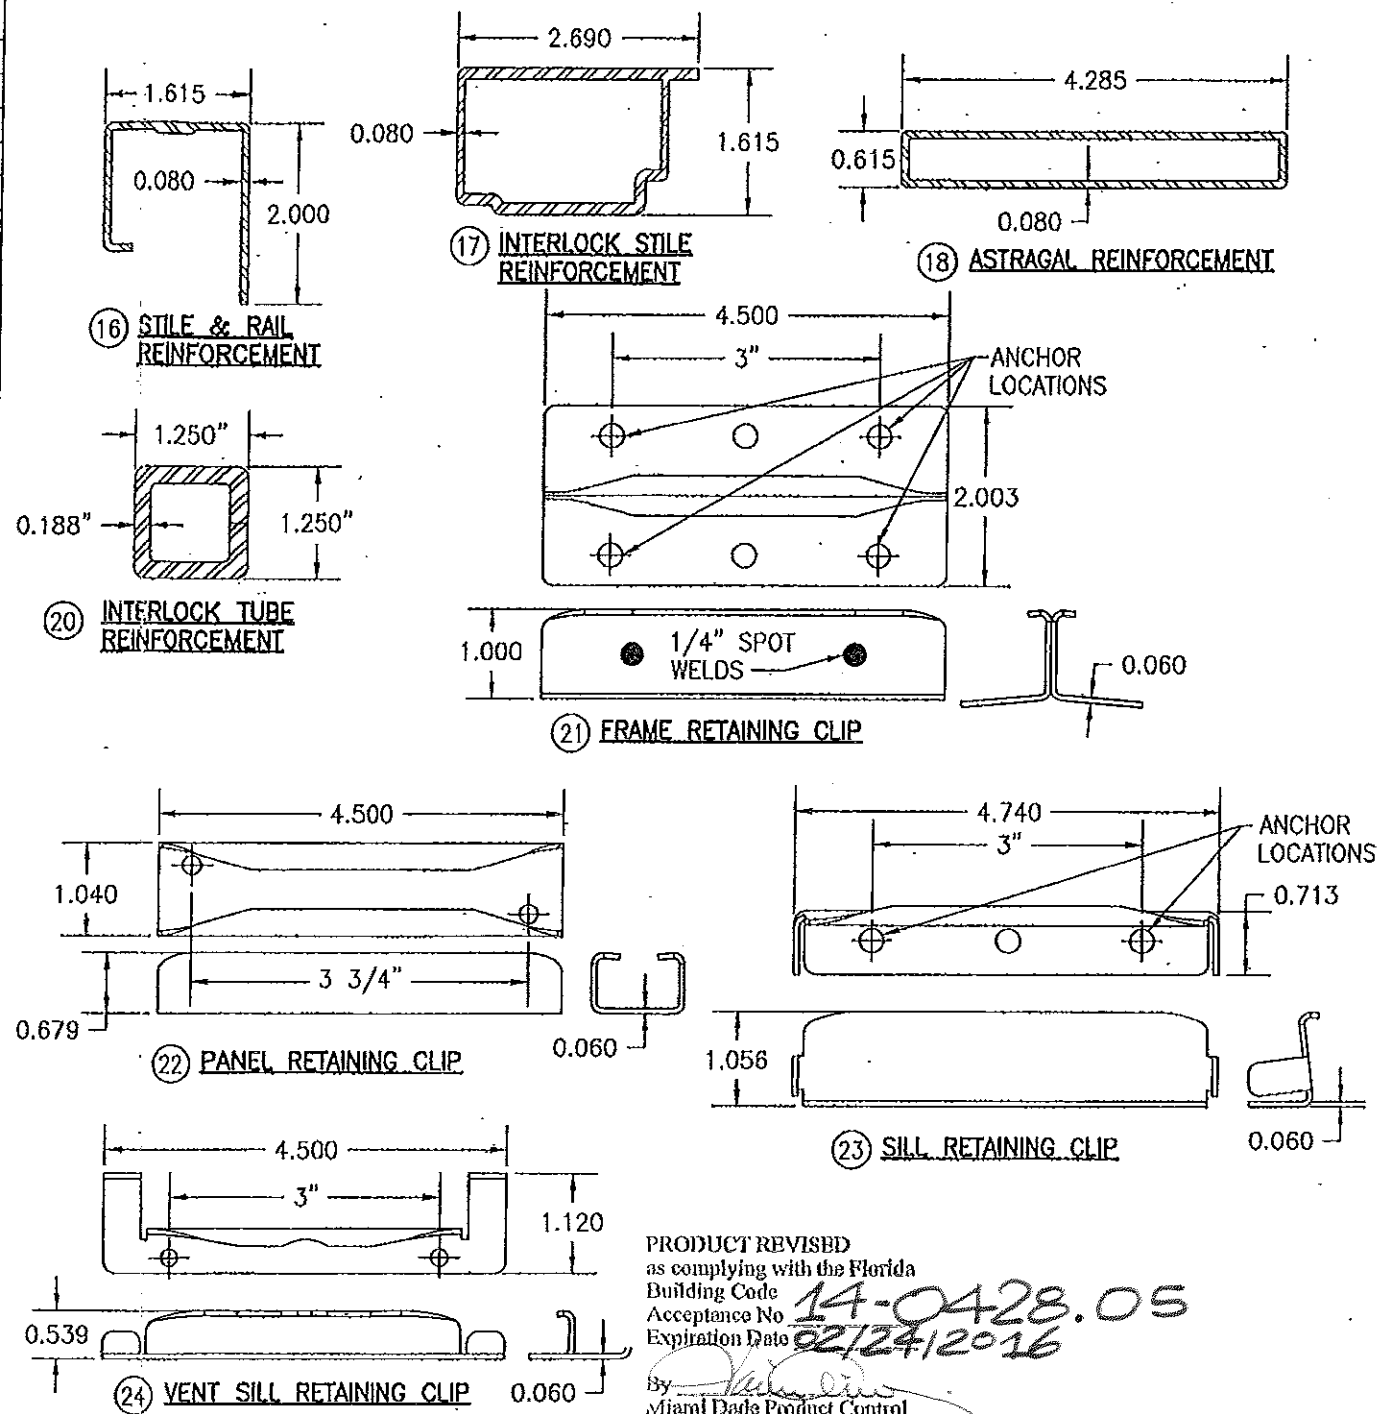

PRODUCT REVISED
as complying with the Florida
Building Code
Acceptance No. 14-0428.05
Expiration Date 02/24/2016
By [Signature]
Miami Dade Product Control

PRODUCT REVISED
as complying with the Florida
Building Code
Acceptance No. 11-1026.15
Expiration Date 02/24/2016
By [Signature]
Miami Dade Product Control

Approved as complying with the
Florida Building Code
Date 02/24/2011
NOA# 15-1124.01
Miami Dade Product Control
By [Signature]

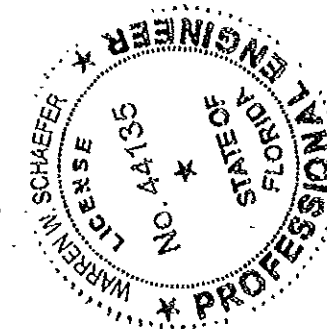

DRAWN BY: W.R.M.		CHECKED BY: W.M.S.	
PLOT: 1=2		DATE: 10/15/10	
DATE	BY	REVISION DESCRIPTION	NO.
DRAWING TITLE: 350 SERIES PREMIUM VINYL IMPACT SLIDING GLASS DOOR			
CONSULTANTS: W. W. SCHAEFER ENGINEERING & CONSULTING, P.A. (CA 6809)		MANUFACTURER: PELLA CORPORATION	
7480 150TH COURT NORTH, PALM BEACH GARDENS, FL 33418		102 MAIN STREET, PELLA, IA 50219	
PHONE: 561-744-3424		641-621-1000	
CERTIFICATION: JAN 27 2011		DRAWING NO. 1691	
SHEET NO. 7 OF 7		REV.	